

# EXACT ENGINEERS

## PROPOSED DUAL OCCUPANCY

10 SAURINE STREET, BANKSTOWN

DRAWING INDEX - STORMWATER			
Sheet Number	Revision	Date	Sheet Title
S-0.0	A	11/02/25	COVER SHEET
S-0.1	A	11/02/25	GENERAL NOTES - SHEET 1
S-1.1	A	11/02/25	STORMWATER PLAN
S-1.2	A	11/02/25	STORMWATER PLAN - SHEET 2
S-2.1	A	11/02/25	STORMWATER DETAILS - SHEET 1
S-2.2	A	11/02/25	STORMWATER DETAILS - SHEET 2
S-2.3	A	11/02/25	STORMWATER DETAILS - SHEET 3
S-2.4	A	11/02/25	STORMWATER DETAILS - SHEET 4



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PROJECT  
PROPOSED DUAL OCCUPANCY  
10 SAURINE STREET, BANKSTOWN

TITLE  
COVER SHEET

CLIENT  
BORIS GRGUREVIC & ASSOCIATES P/L

REV	ISSUE / REVISION DESCRIPTION	DATE	TITLE	NAME
A	ISSUE FOR APPROVAL	11/02/25	DRAWN	E.N
-	-	-	CHECKED	Z.C
-	-	-	SCALE @ A3	N/A
-	-	-	JOB No.	SHEET No.
-	-	-	JB783	S-0.0

**GENERAL NOTES:**

1. ALL WORKS SHALL BE IN ACCORDANCE WITH B.C.A AND AS3500.3.
2. ALL EXISTING LEVELS TO BE CONFIRMED BY BUILDER PRIOR TO CONSTRUCTION.
3. THE BUILDER SHALL ENSURE THAT THE STORMWATER ENGINEERS DRAWINGS CORRESPOND TO THE ARCHITECTURAL, STRUCTURAL, AND LANDSCAPING DRAWINGS. IF THERE EXISTS ANY DISCREPANCIES BETWEEN THE DRAWINGS, THE BUILDER SHALL REPORT THE DISCREPANCIES TO THE ENGINEER PRIOR TO COMMENCEMENT OF ANY WORKS.
4. PRIOR TO COMMENCING ANY WORKS, THE BUILDER SHALL ENSURE THAT THE INVERT LEVELS OF WHERE THE SITE STORMWATER SYSTEM CONNECTS INTO THE COUNCIL'S KERB/DRAINAGE SYSTEM MATCHED THE DESIGN LEVELS. ANY DISCREPANCIES SHALL BE REPORTED TO THE DESIGN ENGINEER.
5. THE DRAINAGE CONTRACTOR IS TO LOCATE AND RELOCATE AS NECESSARY ALL SERVICES ON SITE.
6. ALL LEVELS SHALL RELATE TO THE ESTABLISHED BENCH MARK. THIS IS TYPICALLY METRES TO AUSTRALIAN HEIGHT DATUM (AHD).
7. ALL DOWNPIPES TO BE 100MM DIAMETER UNLESS NOTED OTHERWISE.
8. ALL DOWN PIPES TO HAVE LEAF GUARDS.
9. ALL LINES ARE TO BE 100MM DIAMETER uPVC AT A MINIMUM 1.0% SLOPE UNLESS NOTED OTHERWISE. LINES ARE TO BE SEWER-GRADE AND SEALED.
10. ALL PIPES TO HAVE MINIMUM 150MM COVER IF LOCATED WITHIN PROPERTY.
11. ALL THE CLEANING EYES (OR INSPECTION EYES) FOR THE UNDERGROUND PIPES HAVE TO BE TAKEN UP TO THE FINISHED GROUND LEVEL FOR EASY IDENTIFICATION AND MAINTENANCE PURPOSES.
12. ALL SUB-SOIL DRAINAGE SHALL BE OF A MINIMUM 100MM DIAMETER AND SHALL BE PROVIDED WITH A FILTER SOCK. THE SUBSOIL DRAINAGE SHALL BE INSTALLED IN ACCORDANCE WITH DETAILS TO BE PROVIDED BY THE LANDSCAPE ARCHITECT OR STORMWATER ENGINEER.
13. ALL RETAINING WALLS SHALL BE CONSTRUCTED COMPLETELY WITHIN THE PROPERTY BOUNDARY LIMITS TO DETAILS PREPARED BY THE STRUCTURAL ENGINEER. WALLS FORMING THE ON-SITE DETENTION SYSTEM SHALL BE OF MASONARY/BRICK/CONCRETE CONSTRUCTION AND WATER TIGHT.
14. ALL MULCHING TO BE USED WITHIN THE AREA DESIGNATED AS ON-SITE DETENTION STORAGE SHALL BE OF A NON-FLOTABLE MATERIAL SUCH AS DECORATIVE RIVER GRAVEL. PINE PARK MULCHING SHALL NOT BE USED WITHIN THE DETENTION STORAGE AREA.
15. ALL DRAINAGE WORKS ARE TO AVOID TREE ROOTS. ROOT BARRIER TO BE INSTALLED ADJACENT TO TREE ZONES WHERE DRAINAGE MAY BE AT RISK.
16. ALL WORK WITHIN COUNCIL RESERVE TO BE INSPECTED BY COUNCIL PRIOR TO CONSTRUCTION.
17. COUNCIL'S ISSUED FOOTWAY DESIGN LEVELS TO BE INCORPORATED INTO THE FINISHED LEVELS ONCE ISSUED BY COUNCIL.

**RAINWATER TANKS:**


1. RAINWATER TANK, DRAINED ROOF AREAS AND REUSE PLUMBING TO COMPLY WITH BASIX REQUIREMENTS AND CERTIFICATE.
2. ADEQUATE SCREENING TO PREVENT MOSQUITO BREEDING AND ENTRY OF ANIMAL OR FLOATING MATTER.
3. A 'FIRST FLUSH' DIVERSION TO REMOVE ROOF CONTAMINANTS MUST BE PROVIDED.
4. TANKS TO BE PUMPED TO TOP-UP FROM THE POTABLE WATER SUPPLY DURING DRY PERIOD WHEN THE TANK IS 80% EMPTY.
5. PUMP TO BE SUITABLY SOUNDPROOFED.
6. A SIGN IS TO BE INSTALLED NEAR THE RAINWATER TANK HIGHLIGHTING "NOT FOR HUMAN CONSUMPTION".

**SEDIMENT & EROSION CONTROL:**


1. PLANS ARE MINIMUM REQUIREMENTS AND ARE TO BE USED AS A GUIDE ONLY. EXACT MEASURES USED SHALL BE DETERMINED ON SITE IN CONJUNCTION WITH PROGRAM OF CONTRACTORS WORKS.
2. IMMEDIATELY FOLLOWING SETTING OUT OF THE WORKS, BUT PRIOR TO COMMENCEMENT OF ANY CLEARING OR EARTHWORKS, THE CONTRACTOR AND SUPERINTENDENT SHALL WALK THE SITE TO NOMINATE THE LOCATIONS AND TYPES OF SEDIMENT AND EROSION CONTROL MEASURE TO BE ADOPTED. THESE MEASURES SHALL BE IMPLEMENTED PRIOR TO ANY CLEARING OR EARTHWORKS AND MAINTAINED UNTIL THE WORKS ARE COMPLETED AND NO LONGER POSE AN EROSION HAZARD, UNLESS OTHERWISE APPROVED BY THE SUPERINTENDENT.
3. IMMEDIATELY FOLLOWING SETTING OUT OF THE WORKS, BUT PRIOR TO COMMENCEMENT OF ANY CLEARING OR EARTHWORKS, THE CONTRACTOR AND SUPERINTENDENT SHALL WALK THE SITE TO IDENTIFY AND MARK TREES WHICH ARE TO BE PRESERVED. NOTWITHSTANDING THE ABOVE, THE CONTRACTOR SHALL TAKE ALL REASONABLE PRECAUTIONS TO MINIMISE DISTURBANCE TO EXISTING VEGETATION AND GROUND COVER OUTSIDE THE MINIMUM AREAS REQUIRED TO COMPLETE THE WORKS AND SHALL BE RESPONSIBLE FOR RECTIFICATION, AT ITS OWN COST, OF ANY DISTURBANCE BEYOND THOSE AREAS.
4. PROVIDE GULLY GRATE INLET SEDIMENT TRAPS AT ALL GULLY PITS.
5. PROVIDE SILT FENCING ALONG PROPERTY LINE AS DIRECTED BY SUPERINTENDENT.
6. ADDITIONAL CONTROL DEVICES TO BE PLACED WHERE DIRECTED BY THE PRINCIPLE.
7. ALTERNATIVE DESIGNS TO BE APPROVED BY SUPERINTENDENT PRIOR TO CONSTRUCTION.
8. WASH DOWN/RUMBLE AREA TO BE CONSTRUCTED WITH PROVISIONS RESTRICTING ALL SILT AND TRAFFICKED DEBRIS FROM ENTERING THE STORMWATER SYSTEM.
9. NO WORK OR STOCKPILING OF MATERIALS TO BE PLACED OUTSIDE OF SITE WORK BOUNDARY.
10. APPROPRIATE EROSION AND SEDIMENT CONTROLS TO BE USED TO PROTECT STOCKPILES AND MAINTAINED THROUGHOUT CONSTRUCTION.
11. IT IS THE CONTRACTORS RESPONSIBILITY TO TAKE DUE CARE OF NATURAL VEGETATION. NO CLEARING IS TO BE UNDERTAKEN WITHOUT PRIOR APPROVAL FROM THE SUPERINTENDENT.
12. TO AVOID DISTURBANCE TO EXISTING TREES, EARTHWORKS WILL BE MODIFIED AS DIRECTED ON SITE BY THE SUPERINTENDENT.

**SEDIMENT FENCE:**


1. FILTER CLOTH TO BE FASTENED SECURELY TO POSTS WITH GALVANISED WIRE TIES, STAPLES OR ATTACHMENT BELTS.
2. WHEN TWO SECTIONS OF FILTER CLOTH ADJOIN EACH OTHER THEY SHALL BE OVERLAPPED BY 150MM AND FOLDED.
3. POSTS SHALL NOT BE SPACED MORE THAN 3.0 METRES APART.
4. FOR EXTRA STRENGTH TO SILT FENCE, WOVEN WIRE (14MM GAUGE, 150MM MESH SPACING) TO BE FASTENED SECURELY BETWEEN FILTER CLOTH AND POSTS BY WIRE TIES OR STAPLES
5. INSPECTIONS SHALL BE PROVIDED ON A REGULAR BASIS, SPECIALLY AFTER RAINFALL AND EXCESSIVE SILT DEPOSITS REMOVED WHEN "BULGES" DEVELOP IN SILT FENCE SEDIMENT FENCES SHALL BE CONSTRUCTED WITH SEDIMENT TRAPS AND EMERGENCY SPILLWAYS AT SPACINGS NO GREATER THAN 40M ON FLAT TERRAIN DECREASING TO 20M SPACINGS ON STEEP TERRAIN
  - ALL WORK TO BE IN ACCORDANCE WITH AS3500.3.1 AND AS3500.3.2
  - NOTIFY ENGINEER OF ANY DISCREPANCIES ON SITE
  - DIAL BEFORE YOU DIG. PRIOR TO COMMENCING WORK.
  - SILT ARRESTOR/ GRATED INLET PITS 450X450 U.N.O
  - ALL WORK IN ACCORDANCE WITH THE LOCAL GOVERNMENT ACT. COUNCILS STANDARD SPECIFICATION AND CODES AND TO THE SATISFACTION OF COUNCILS SUPERVISING OFFICER.
  - THIS PLAN TO BE READ IN CONJUNCTION WITH PLANS PREPARED BY THE ARCHITECTS AND STRUCTURAL ENGINEERS PLANS.
  - INSTALL TEMPORARY SEDIMENT BARRIERS AROUND ALL INLET PITS TO DETAIL UNTIL SURROUNDING AREAS ARE PAVED OR GRASSED.
  - CONTRACTOR IS TO VERIFY THE LOCATION AND LEVEL OF ALL EXISTING SERVICES PRIOR TO COMMENCEMENT OF EXCAVATION FOR DRAINAGE.
  - ALL PITS TO BE BENCHED TO HALF PIPE SECTION AND TO HAVE GALVANISED STEEL GRATES AND SURROUNDS.
  - PIPE GRADES SHOWN ARE INDICATIVE MINIMUM.
  - PIPES ARE TO BE LAID TO I.L. LEVELS INDICATED AT PITS.
  - ALL STORMWATER TO CONNECT TO EXISTING STORMWATER MAIN, LOCATION TO BE CONFIRMED ONSITE

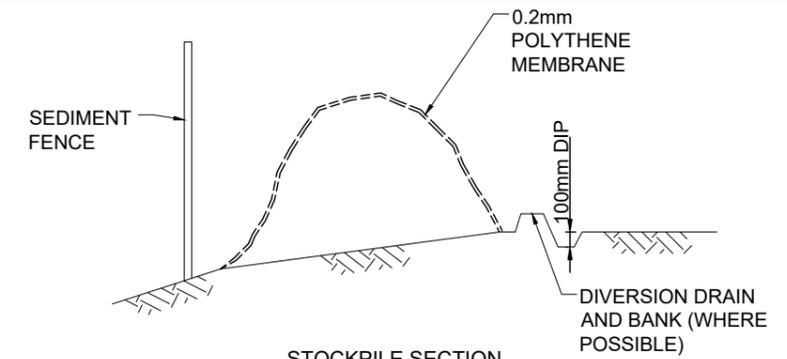


**STOCKPILE SECTION**

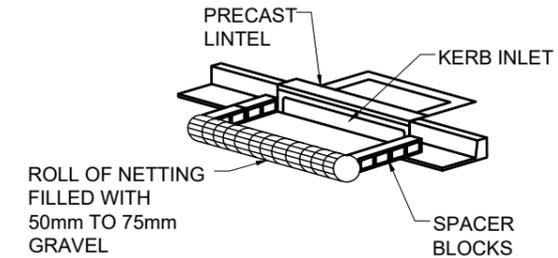

**KERB INLET PROTECTION DETAIL**

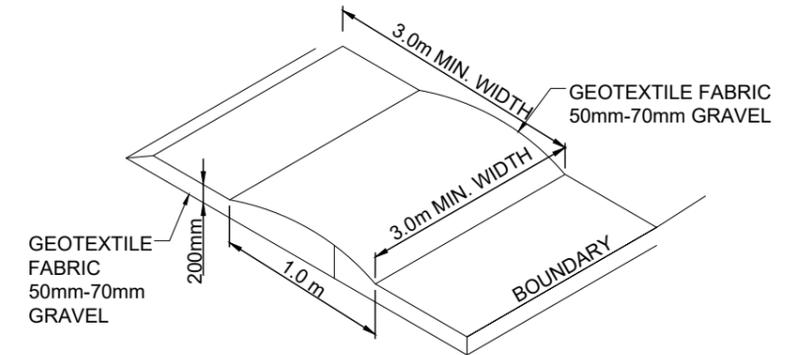

**TEMPORARY CONSTRUCTION**

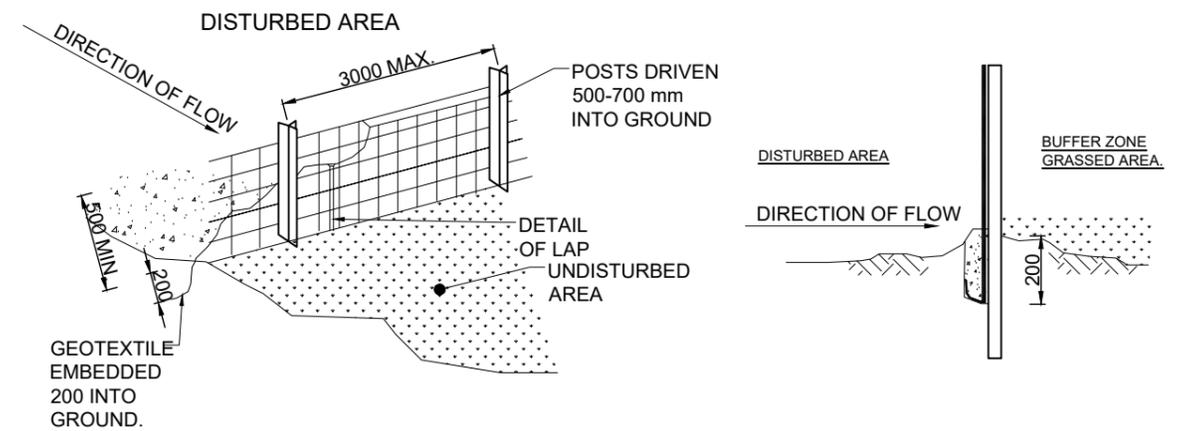


**SEDIMENT FENCE DETAIL**



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	-	-	-	CHECKED	Z.C
GENERAL NOTES - SHEET 1	-	-	-	SCALE @ A3	N/A
	-	-	-	JOB No.	SHEET No.
CLIENT BORIS GRGUREVIC & ASSOCIATES P/L	-	-	-	JB783	S-0.1
	-	-	-	-	-




**GROUND FLOOR - STORMWATER PLAN**
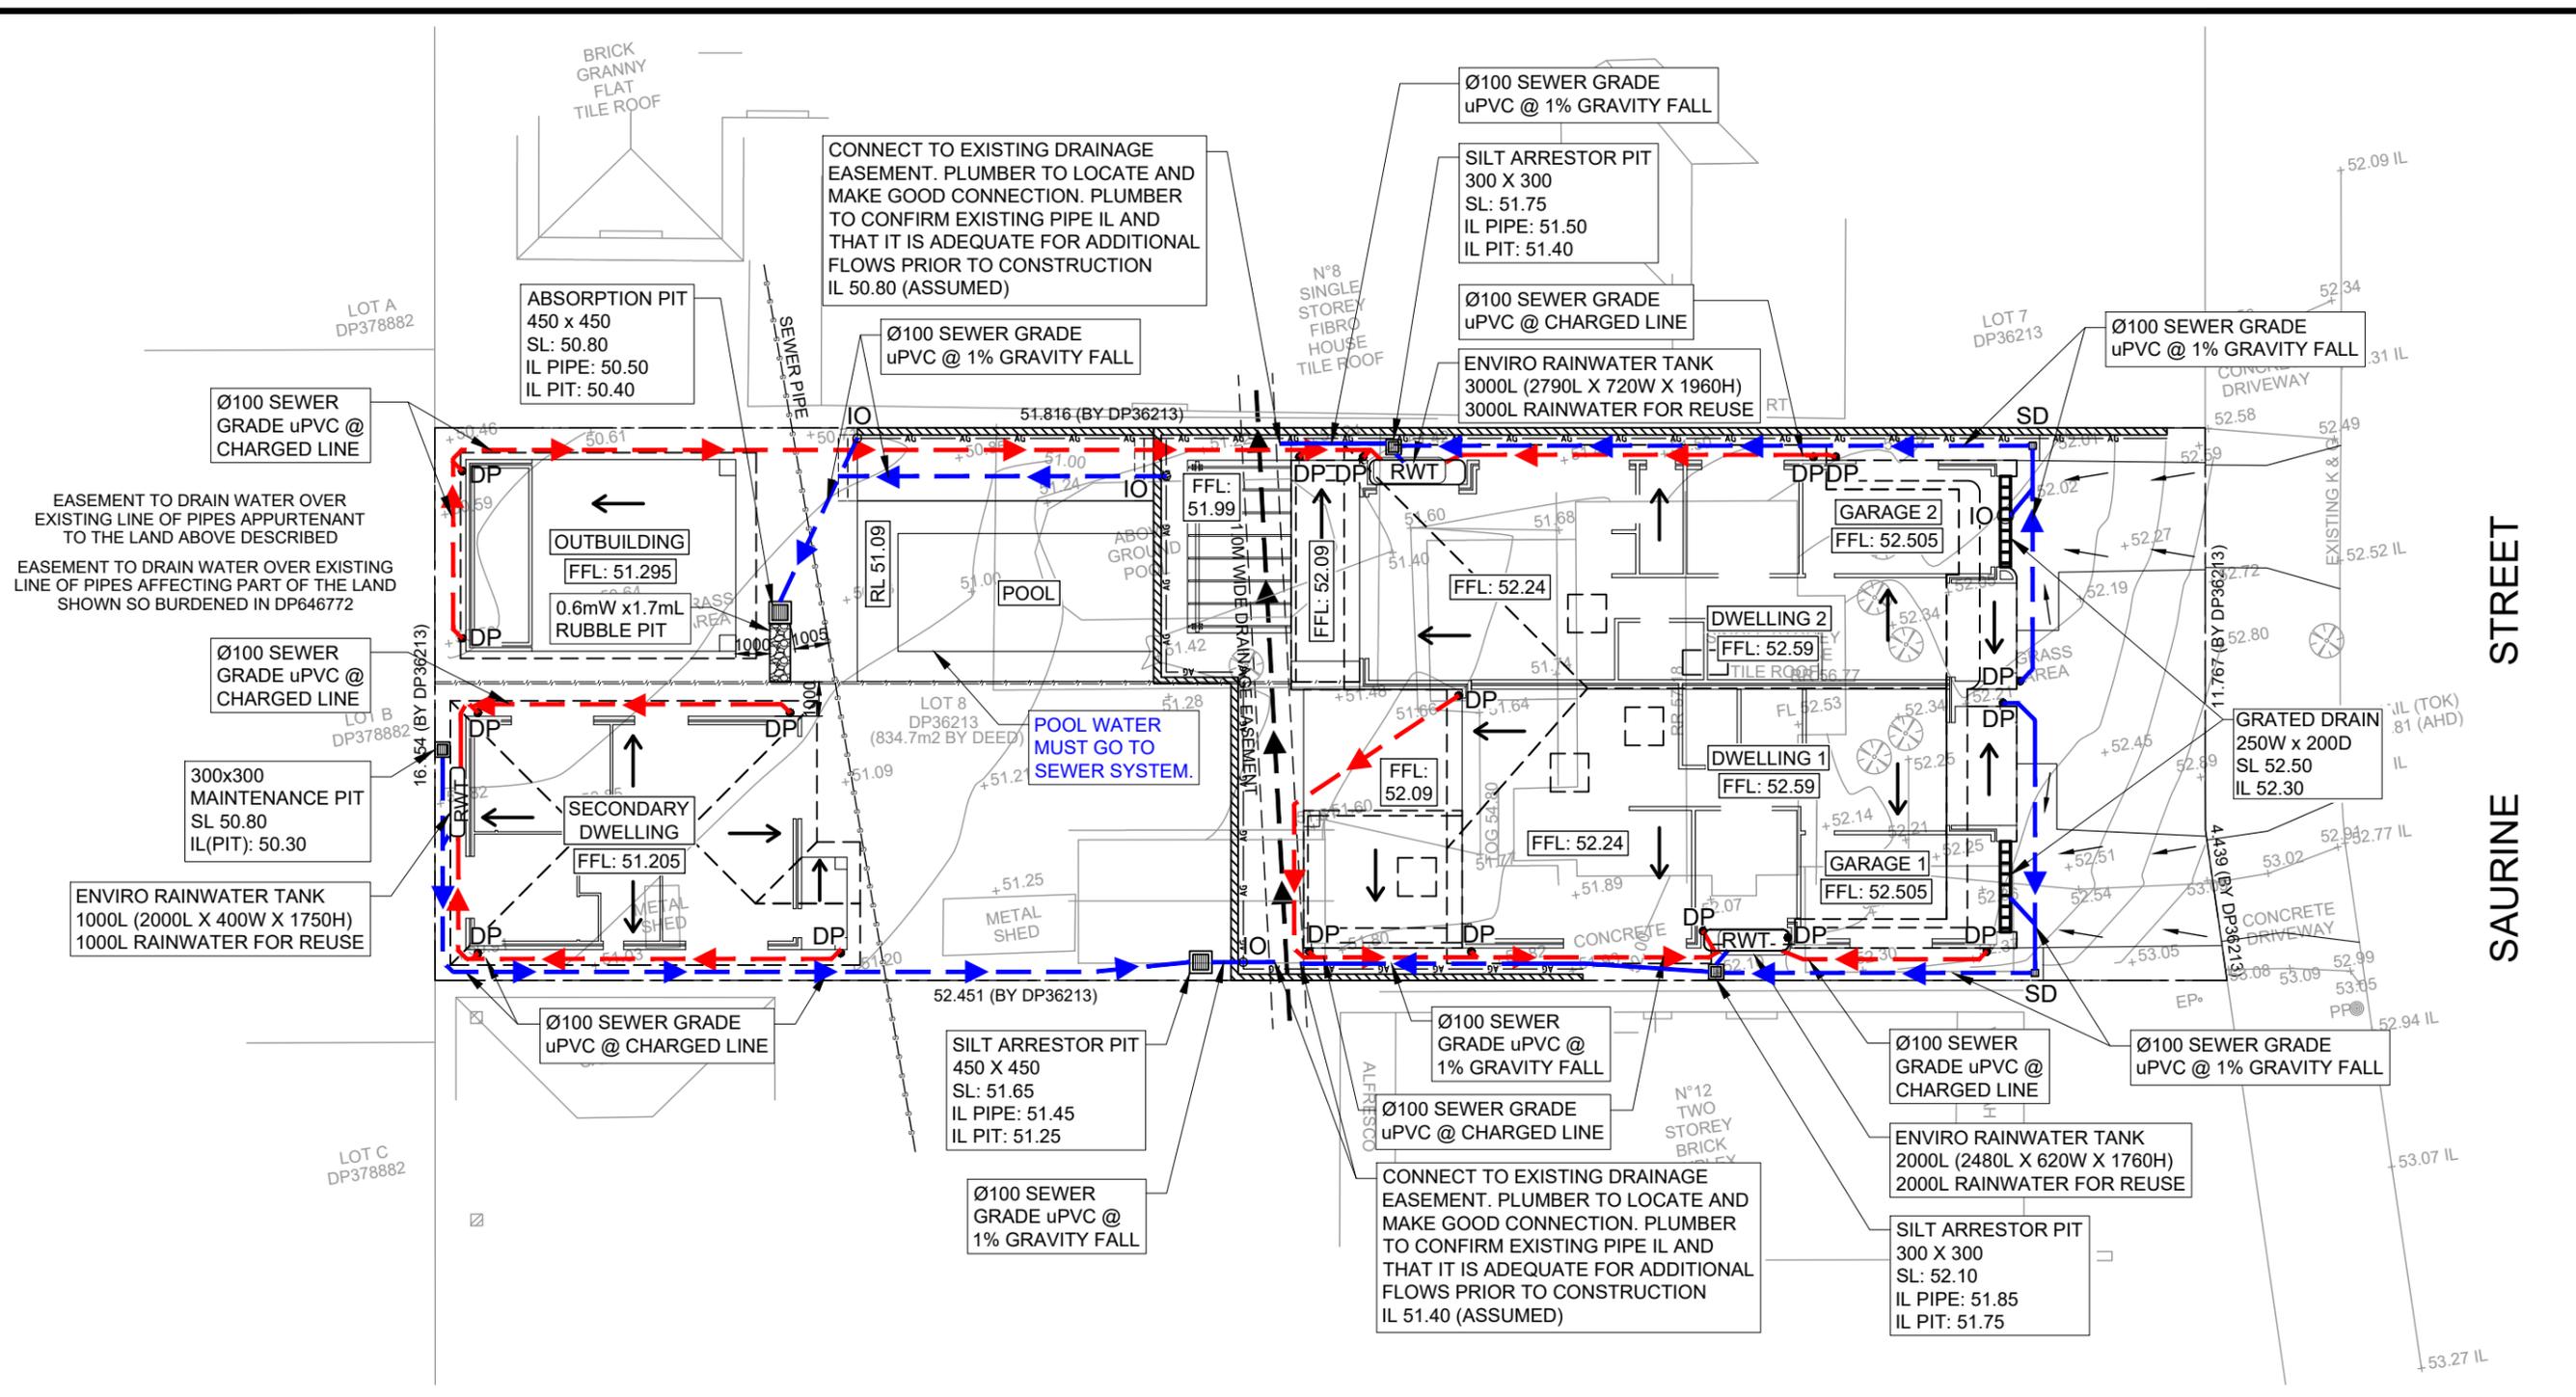
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	TITLE						CHECKED	Z.C
							SCALE @ A3	1:200
	CLIENT						JOB No.	SHEET No.
	BORIS GRGUREVIC & ASSOCIATES P/L						JB783	S-1.1

## DESIGN SUMMARY

CANTERBURY-BANKSTOWN COUNCIL  
 SITE AREA = 834.4 (APPROX) m<sup>2</sup>  
 DWELLING 1 ROOF AREA = 233.5 m<sup>2</sup> (APPROX)  
 DWELLING 2 ROOF AREA = 197.6 m<sup>2</sup> (APPROX)  
 1:100 ARI 5MIN. = 204 mm/hr  
 1:20 ARI 5MIN. = 162 mm/hr  
 CATCHMENT PER DP = 37 m<sup>2</sup>

- EAVE GUTTER MINIMUM EFFECTIVE AREA 6200mm<sup>2</sup>
- ALL CHARGED LINES MUST BE OF PRESSURE GRADE AND JOINTS ARE TO BE SOLVENT WELDED
- THE PIPE SYSTEM INCLUDING DOWNPIPES MUST BE CONSTRUCTED FROM SUITABLY DURABLE MATERIALS
- FLUSHING POINTS/SEALED CLEANING EYES ARE TO BE PROVIDED AT LOWEST POINTS IN THE SYSTEM AND AT FRONT BOUNDARY PRIOR TO COUNCIL LAND AND SHOULD BE EASE TO ACCESS
- ALL SURFACE PIT SHALL BE CAST - IN - SITU OR PRECAST CONCRETE PIT

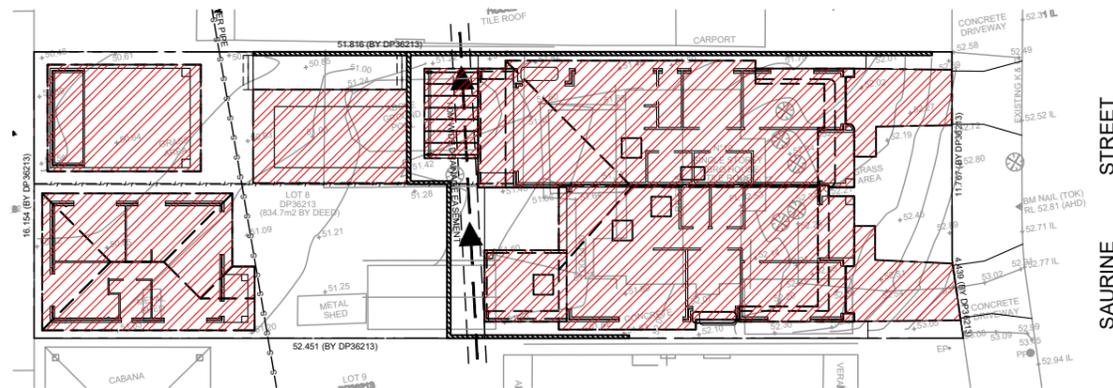

**SITE IMPERVIOUS PLAN**  
 1:400

OSD WARRANT:  
 SITE AREA = 834.4m<sup>2</sup> (APPROX.)  
 PROPOSED IMPERVIOUS AREA = 536.3m<sup>2</sup>  
 PROPOSED PERVIOUS AREA = 298.1m<sup>2</sup>  
 $\frac{536.3}{834.4} \times 100 = 64.3\%$  IMPERVIOUS AREA HENCE NO  
 OSD REQUIRED AS IT IS LESS THAN 66%  
 REFER TO CANTERBURY BANKSTOWN DEVELOPMENT  
 CONTROL PLAN 2023, SECTION 4 - ON-SITE DETENTION  
 SYSTEMS.

CHARGED LINE SYSTEM IS IN ACCORDANCE WITH  
 CANTERBURY BANKSTOWN DEVELOPMENT CONTROL  
 PLAN 2023, SECTION 3.8 - ALTERNATIVE DRAINAGE OF  
 DUAL OCCUPANCIES AND SECTION 3.9 -  
 REQUIREMENTS FOR CHARGED LINES.

## LEGEND

- PROPOSED STORMWATER
- PROPOSED STORMWATER DRAINING TO RWT
- EXISTING STORMWATER
- RETAINING WALL Ø90 AGI PIPE @ 1% GRAVITY FALL
- ROOF SLOPE
- SURFACE FLOW ARROWS
- 90Ø DOWNPIPE
- INSPECTION OPENING
- SURFACE DRAIN
- PROPOSED RWT

SERVICES SHOWN ARE INDICATIVE ONLY.  
 CONTRACTOR SHALL CONFIRM ALL SERVICE  
 LOCATIONS AND DEPTH PRIOR TO EXCAVATION

ALL PIPES AND GUTTERS SIZED FOR STORM  
 EVENTS UP TO AND INCLUDING THE 5% AEP. ALL  
 PIPES TO BE SEWER GRADE uPVC

ALL DRAINAGE LINES BEND AND PITS ARE TO BE  
 SEALED.

PLUMBER TO MAKE GOOD CONNECTION TO  
 COUNCIL STORMWATER PIPE. IF ANY ISSUES  
 CONTACT ENGINEER IMMEDIATELY.

ALL DRAINAGE LINES ARE TO BE A MINIMUM OF Ø100mm  
 SEWER GRADE uPVC @ 1% UNLESS NOTED OTHERWISE.  
 ALL PIPES SIZED FOR 1% AEP STORM EVENT

ALL PIPE WORK IS SHOWN INDICATIVELY/  
 DIAGRAMMATICALLY AND SHOULD NOT BE SCALED OF  
 THE PLAN, THE DOWNPIPES ARE TO RUN ALONG THE WALL  
 OF THE SECONDARY DWELLING



- ALL WORK IS TO BE CARRIED OUT IN ACCORDANCE WITH COUNCIL'S DCP
- THE CONTRACTOR IS TO LOCATE AND LEVEL ALL EXISTING SERVICES PRIOR TO THE COMMENCEMENT OF CONSTRUCTION AND MAKE ARRANGEMENTS WITH THE RELEVANT AUTHORITY TO RELOCATE IF NECESSARY
- ALL PIPES ARE TO BE 100mm U.P.V.C ON 1% MINIMUM GRADE U.N.O AND TO HAVE MIN 200mm COVER





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	-	-	-	-	-
STORMWATER PLAN - SHEET 2	-	-	-	CHECKED	Z.C
	-	-	-	SCALE @ A3	N/A
CLIENT BORIS GRGUREVIC & ASSOCIATES P/L	-	-	-	JOB No.	SHEET No.
	-	-	-	JB783	S-1.2



**TYPICAL WARNING SIGN**

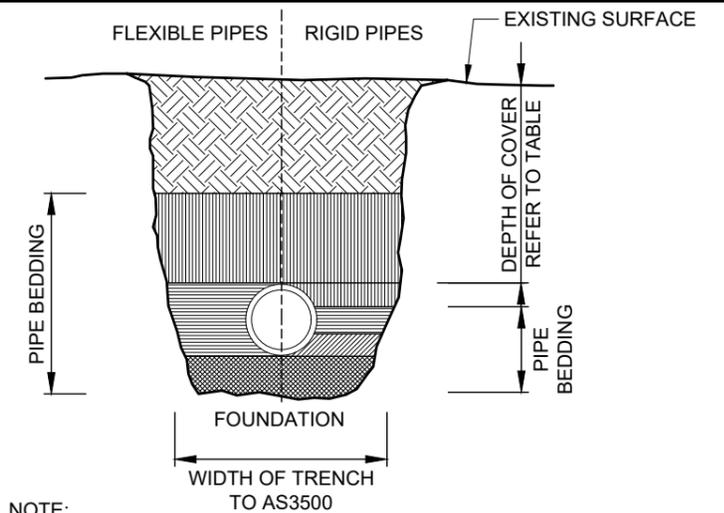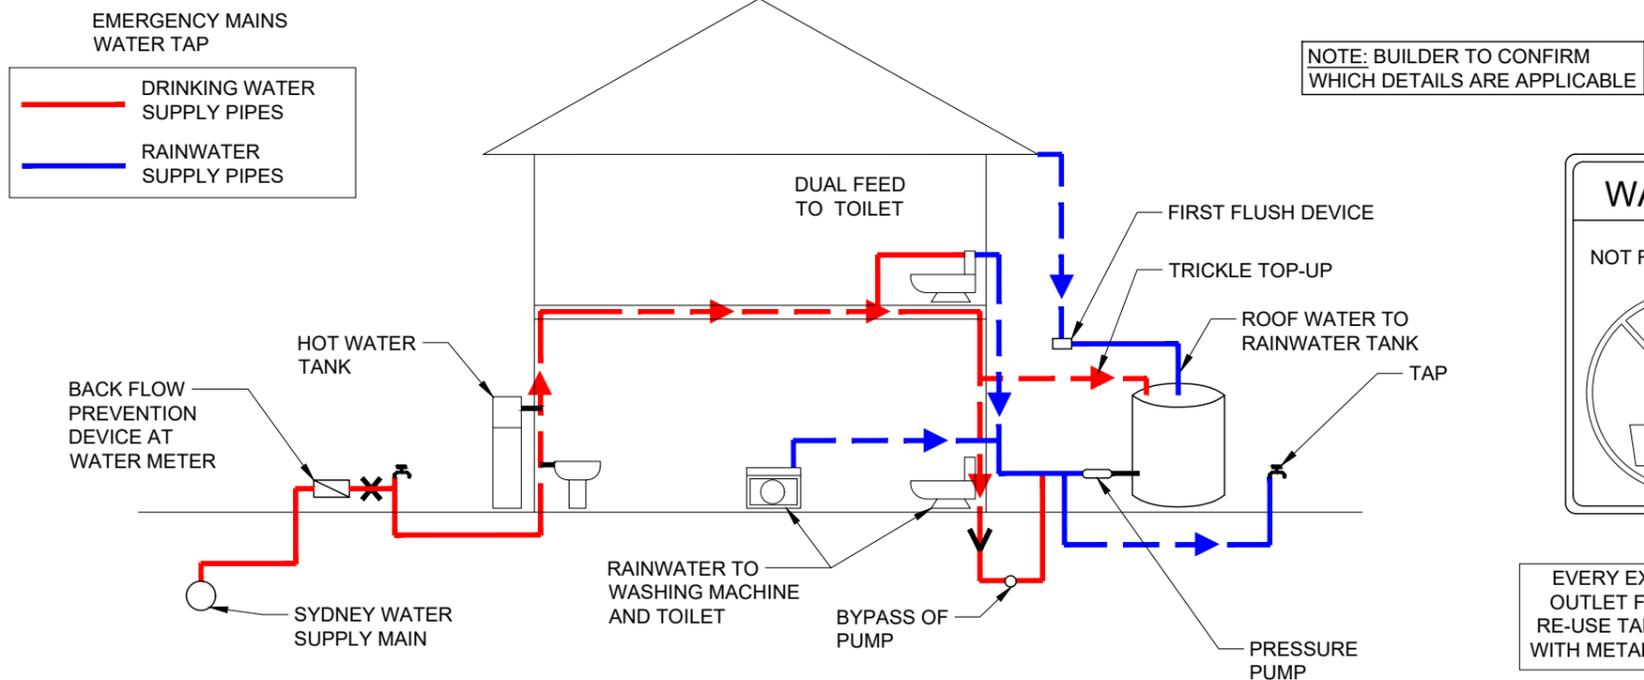


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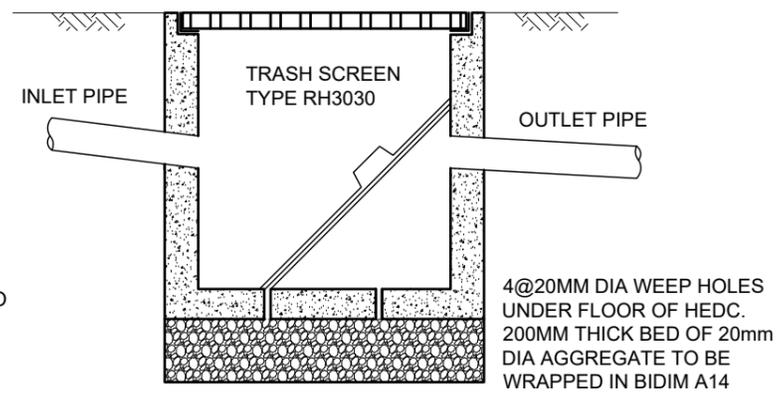
PROJECT	PROPOSED DUAL OCCUPANCY 10 SAURINE STREET, BANKSTOWN
TITLE	STORMWATER DETAILS - SHEET 1
CLIENT	BORIS GRGUREVIC & ASSOCIATES P/L
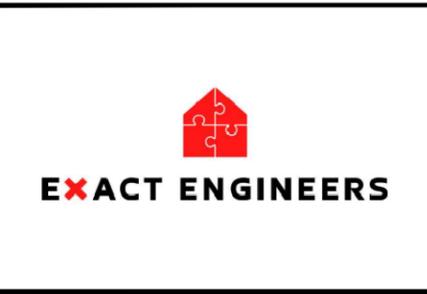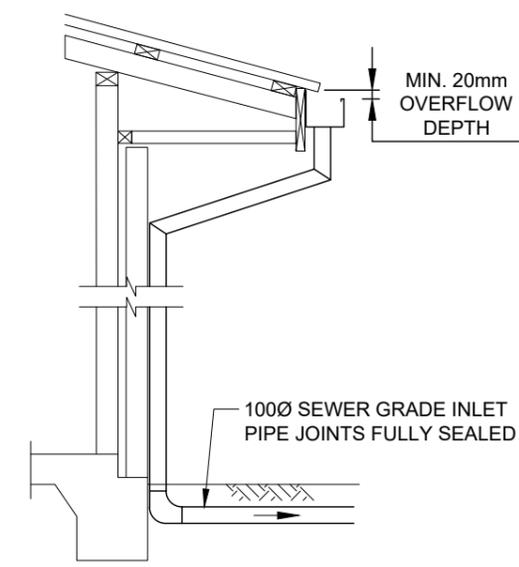
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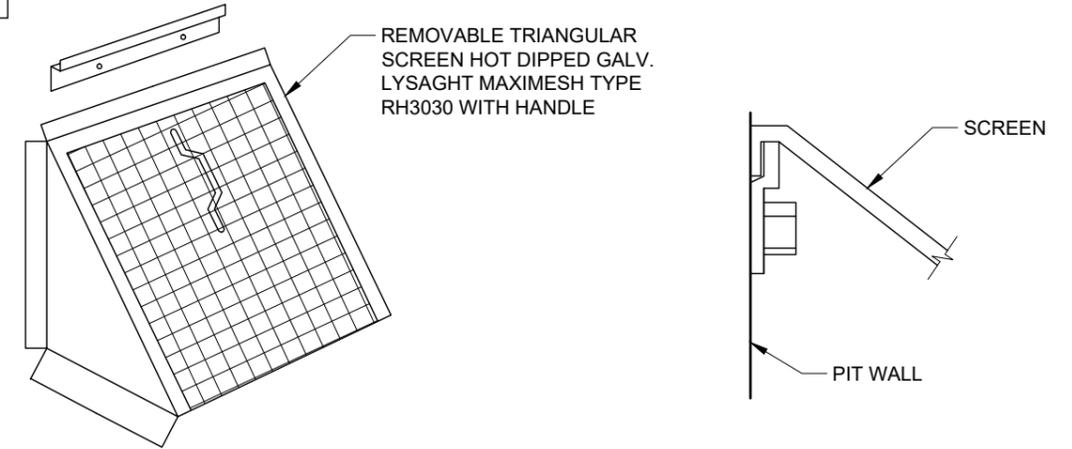
NOTE: BUILDER TO CONFIRM WHICH DETAILS ARE APPLICABLE




TYPICAL INSPECTION RISER DETAIL

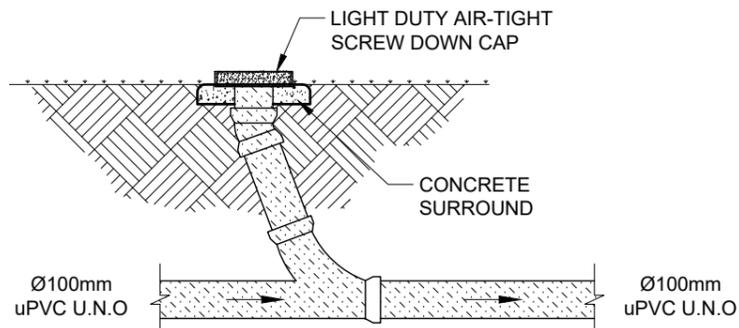

TYPICAL SILT ARRESTOR PIT DETAIL



TYPICAL MULTI-PURPOSE FILTER SCREEN

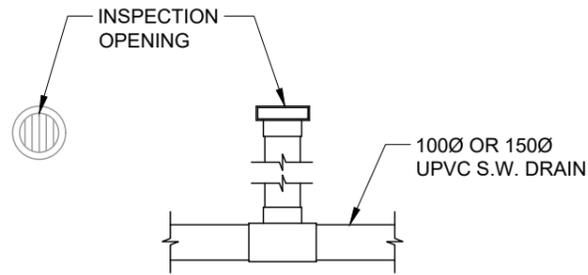


TYPICAL INSPECTION OPENING DETAIL

**SURFACE WATER DRAINAGE - DOMESTIC**


**EasyDRAIN™ SHALLOW & DEEP FLO-WAY™ PITS & GRATES AND RAINWATER PIT**

- Innovative, yet simple approach to solving your drainage problems
- Flo-way Pits are available in two sizes - 75mm shallow and 160mm deep.
- Flo-way Pits suit 90mm or 100mm PVC Pipe.
- Square trap design funnels rainwater direct into a connected stormwater pipe.
- Complete units with grates in black, grey sandstone and terracotta polymer as well as aluminium and EURODESIGN 316 Stainless Steel.

TYPICAL SURFACE DRAIN

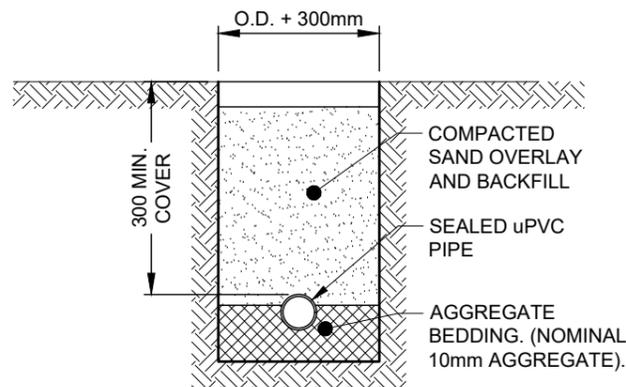

PIPE TRENCH DETAIL

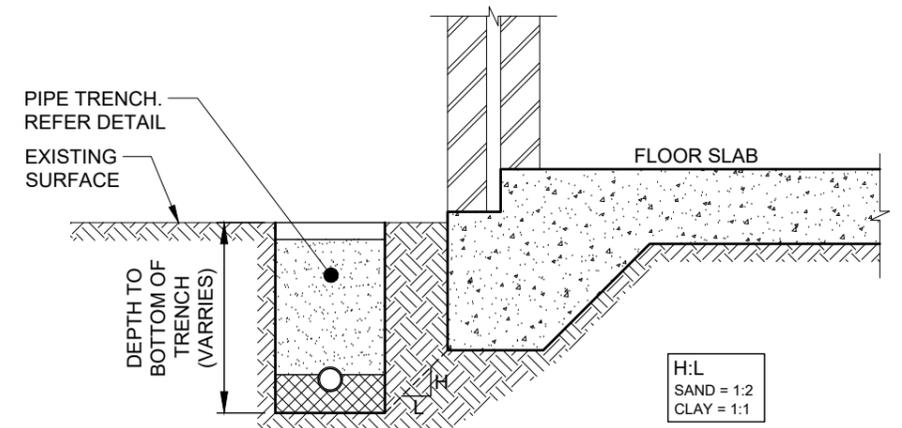

TRENCH EXCAVATION NEAR FOOTINGS




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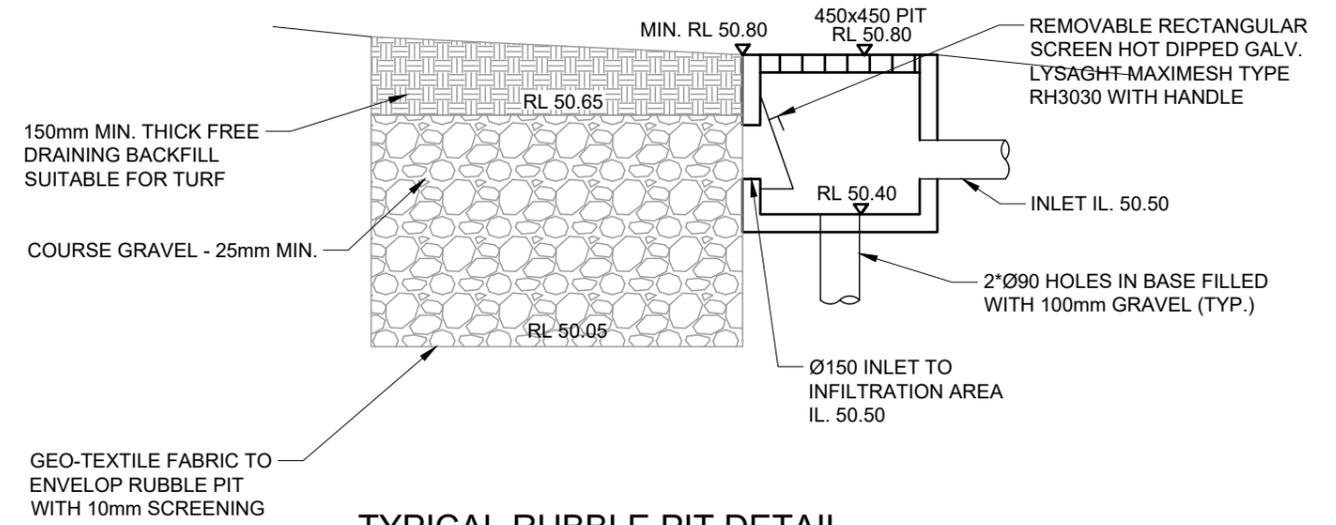


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TITLE	STORMWATER DETAILS - SHEET 2	
CLIENT	BORIS GRGUREVIC & ASSOCIATES P/L	


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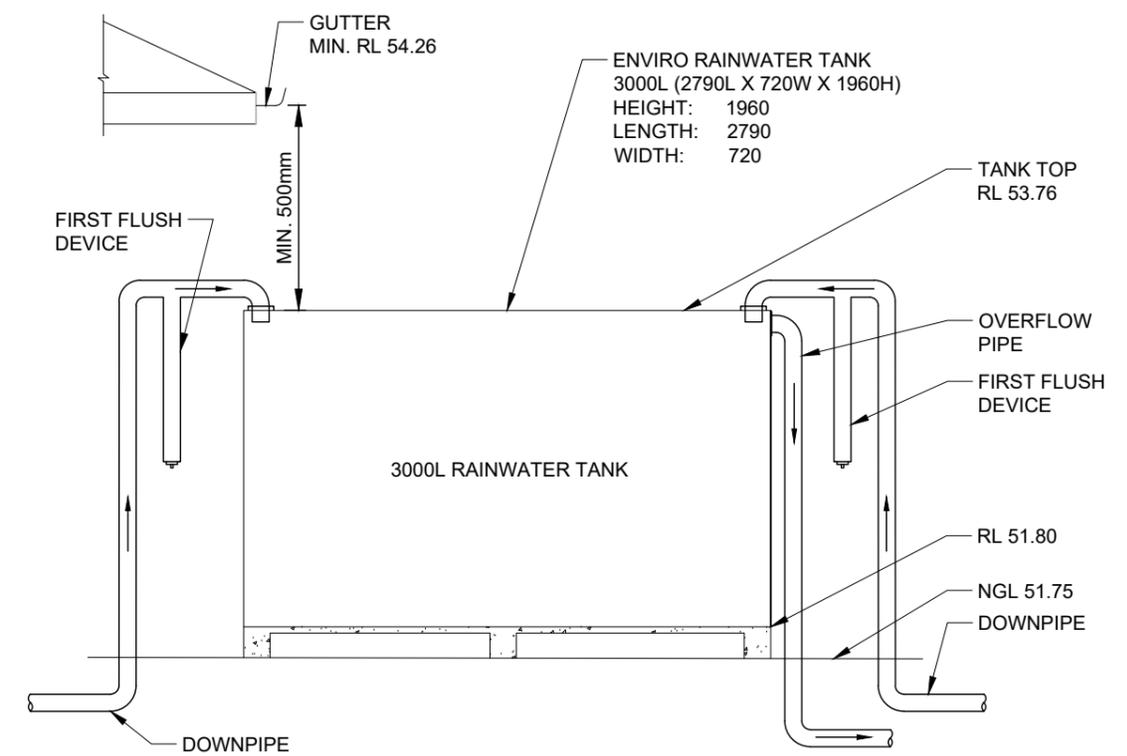
**TYPICAL "CLEAN-OUT" PIT FOR CHARGED LINES**

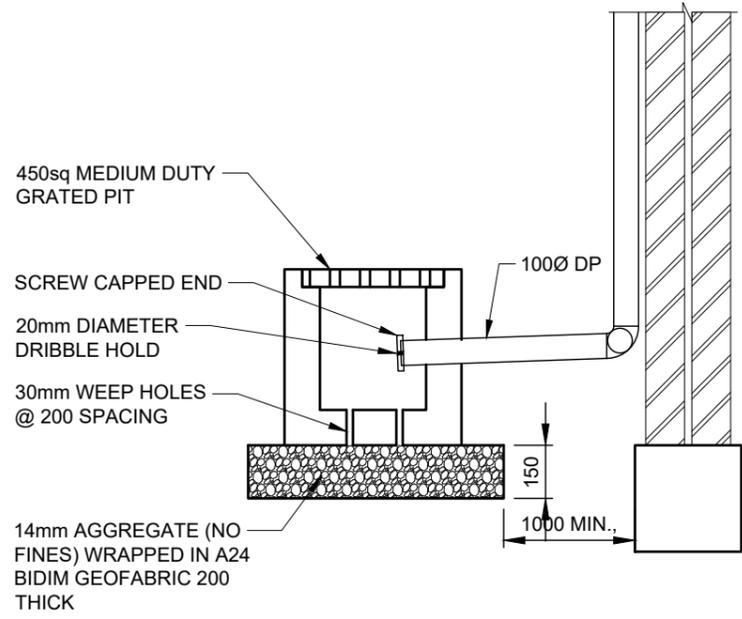

**TYPICAL RUBBLE PIT DETAIL**  
SCALE 1:20



**RAINWATER TANK DETAIL - DWELLING 1**

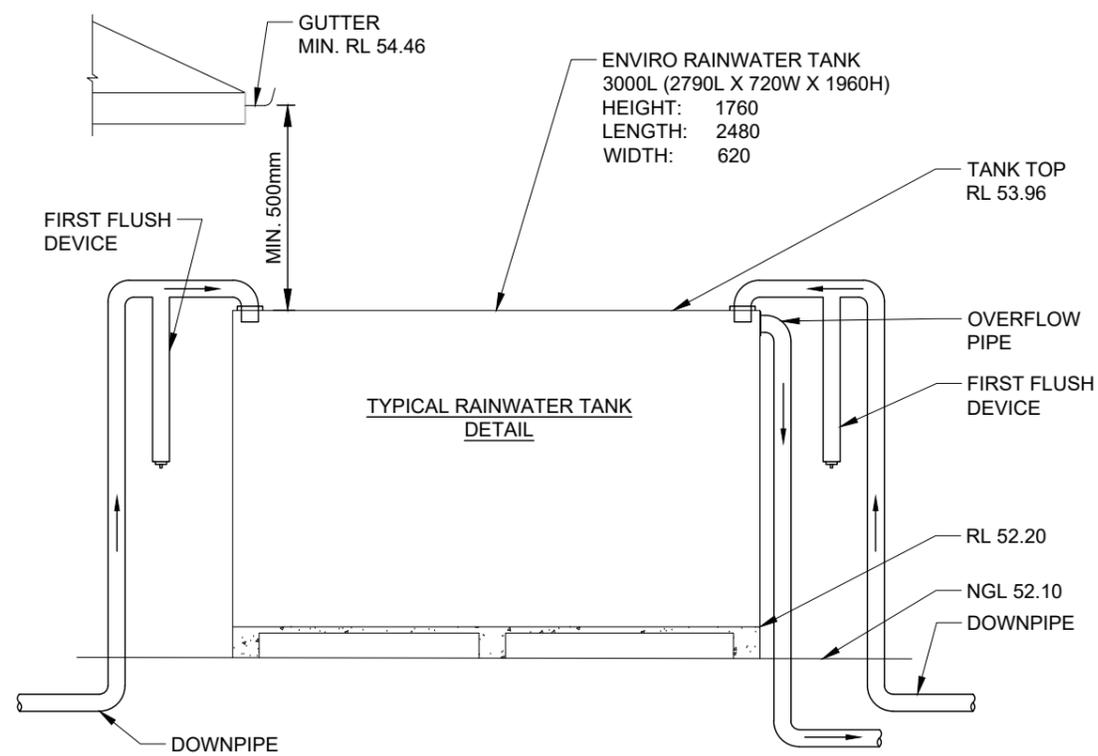

**RAINWATER TANK DETAIL - DWELLING 2**




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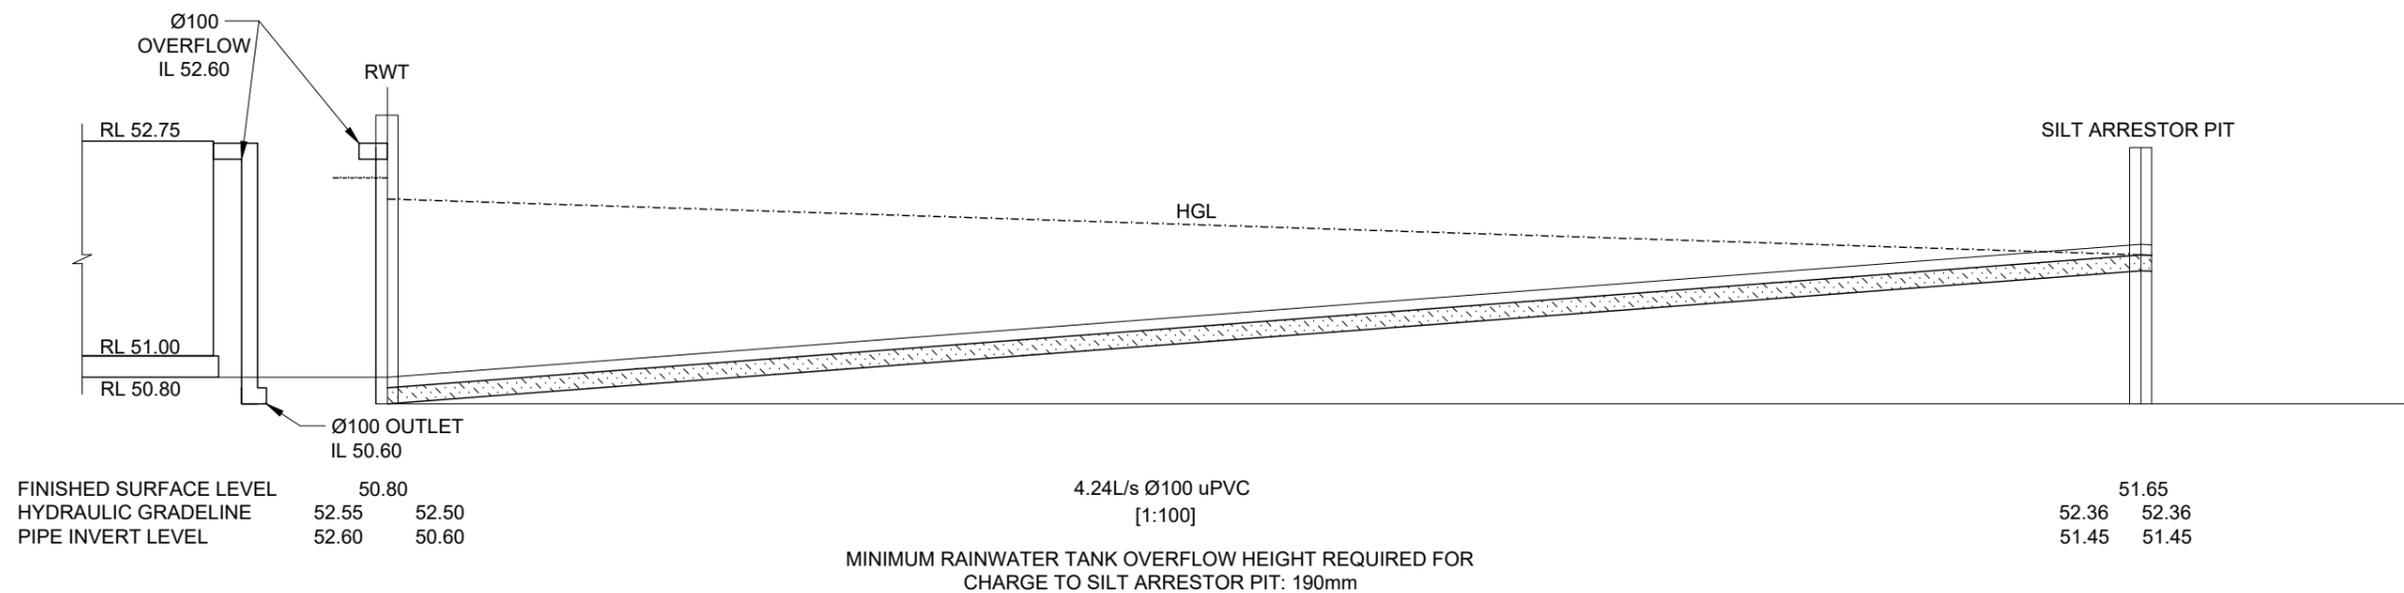


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**RAINWATER RE-USE TANK (SECONDARY DWELLING)**



**HGL ANALYSIS DIAGRAM (SECONDARY DWELLING)**

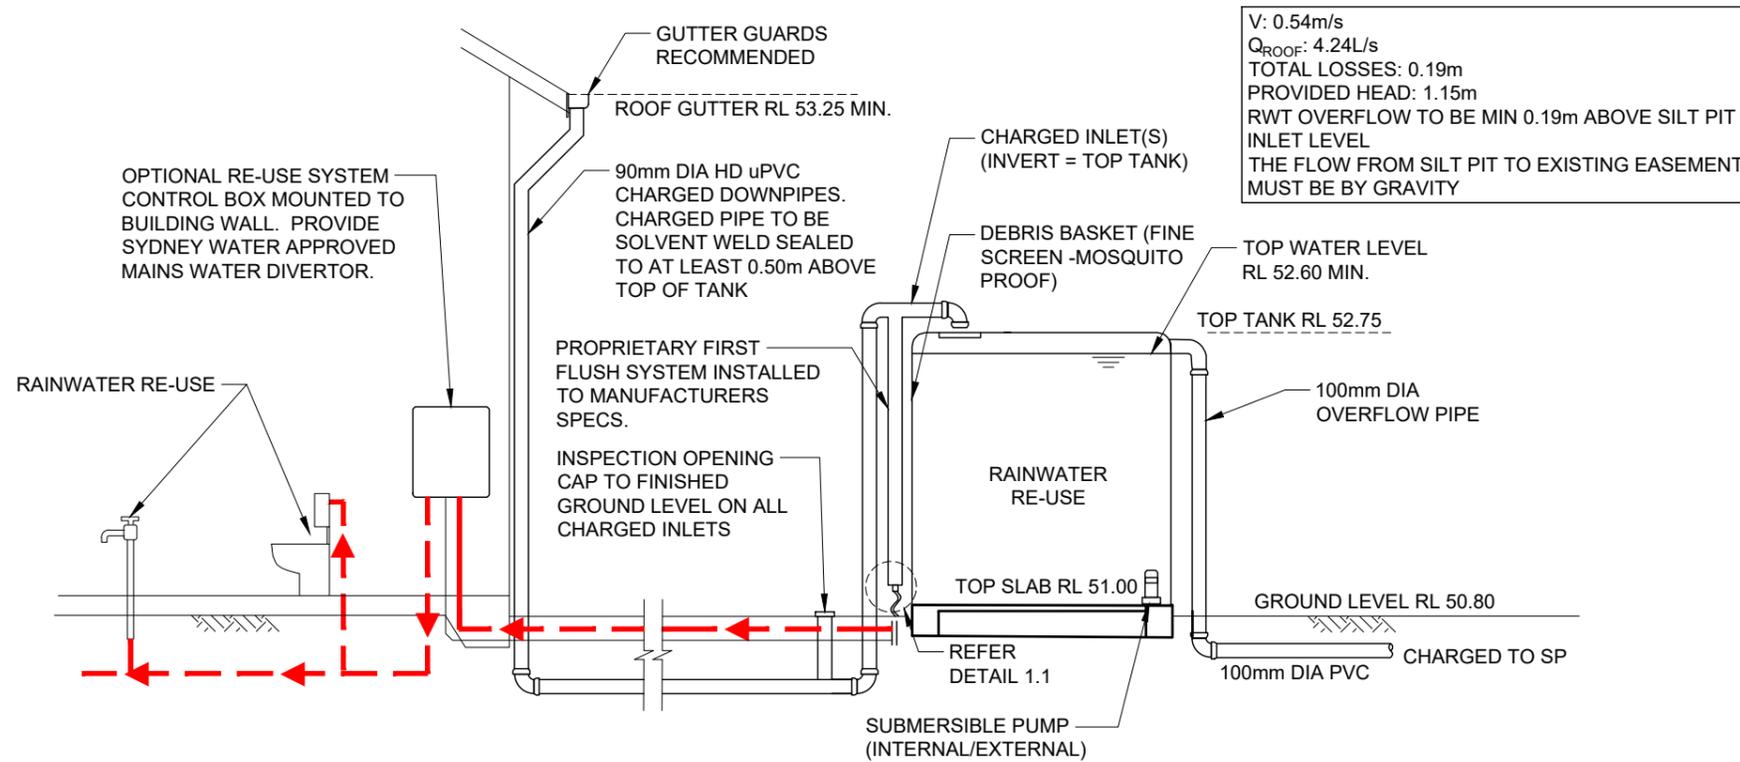

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	-	-	-	-	-
TITLE STORMWATER DETAILS - SHEET 4	-	-	-	CHECKED	Z.C
	-	-	-	SCALE @ A3	1:20
CLIENT BORIS GRGUREVIC & ASSOCIATES P/L	-	-	-	JOB No.	SHEET No.
	-	-	-	JB783	S-2.4